

The Sizewell C Project

2.5 Main Development Site Conventional Island (Unit 2) Plans For Approval

September 2021

Planning Act 2008 Infrastructure Planning (Applications: Prescribed Forms and Procedure) Regulations 2009 Revision: 2.0

Applicable Regulation: Regulation 5(2)(o)

PINS Reference Number: EN010012



Main Development Site, Conventional Island Plans (Unit 2) – For Approval


| Drawing Number | Revision | Drawing Title | Scale | Sheet Size | | | |
|---|----------|-----------------------------------|-------|------------|--|--|--|
| Unit 2: Turbine Hall | | | | | | | |
| SZC-SZ0701-XX-000-DRW-100109 | 02 | Roof Plan, East & West Elevations | 1:200 | A0 | | | |
| SZC-SZ0701-XX-000-DRW-100110 | 02 | North & South Elevations | 1:200 | A0 | | | |
| Unit 2: Conventional Island Electrical Building | | | | | | | |
| SZC-SZ0701-XX-000-DRW-100113 | 02 | Roof Plan | 1:100 | A1 | | | |
| SZC-SZ0701-XX-000-DRW-100114 | 02 | West Evaluations | 1:100 | A1 | | | |
| SZC-SZ0701-XX-000-DRW-100115 | 02 | North & East Elevations | 1:100 | A1 | | | |
| Unit 2: Gas Insulated Switch Gear / Main Transformer / Unit Transformer / Auxiliary Transformer | | | | | | | |
| SZC-SZ0701-XX-000-DRW-100116 | 02 | Roof Plan | 1:200 | A1 | | | |
| SZC-SZ0701-XX-000-DRW-100117 | 02 | Elevations | 1:200 | A1 | | | |





Main Development Site Conventional Island Plans (Unit 2) For Approval – Revisions Schedule

| Drawing Number | Revision | Drawing Title | Amendments | | | | |
|---|----------|-----------------------------------|--|--|--|--|--|
| Unit 2: Turbine Hall | | | | | | | |
| SZC-SZ0701-XX-000-DRW-100109 | 02 | Roof Plan, East & West Elevations | Update to drawing title to ensure consistency with the DCO schedules | | | | |
| SZC-SZ0701-XX-000-DRW-100110 | 02 | North & South Elevations | Update to drawing title to ensure consistency with the DCO schedules | | | | |
| Unit 2: Conventional Island Electrical Building | | | | | | | |
| SZC-SZ0701-XX-000-DRW-100113 | 02 | Roof Plan | Update to drawing title to ensure consistency with the DCO schedules | | | | |
| SZC-SZ0701-XX-000-DRW-100114 | 02 | West Evaluations | Update to drawing title to ensure consistency with the DCO schedules | | | | |
| SZC-SZ0701-XX-000-DRW-100115 | 02 | South & East Elevations | Update to drawing title to ensure consistency with the DCO schedules | | | | |
| Unit 2: Gas Insulated Switch Gear / Main Transformer / Unit Transformer / Auxiliary Transformer | | | | | | | |
| SZC-SZ0701-XX-000-DRW-100116 | 02 | Roof Plan | Update to drawing title to ensure consistency with the DCO schedules | | | | |
| SZC-SZ0701-XX-000-DRW-100117 | 02 | Elevations | Update to drawing title to ensure consistency with the DCO schedules | | | | |



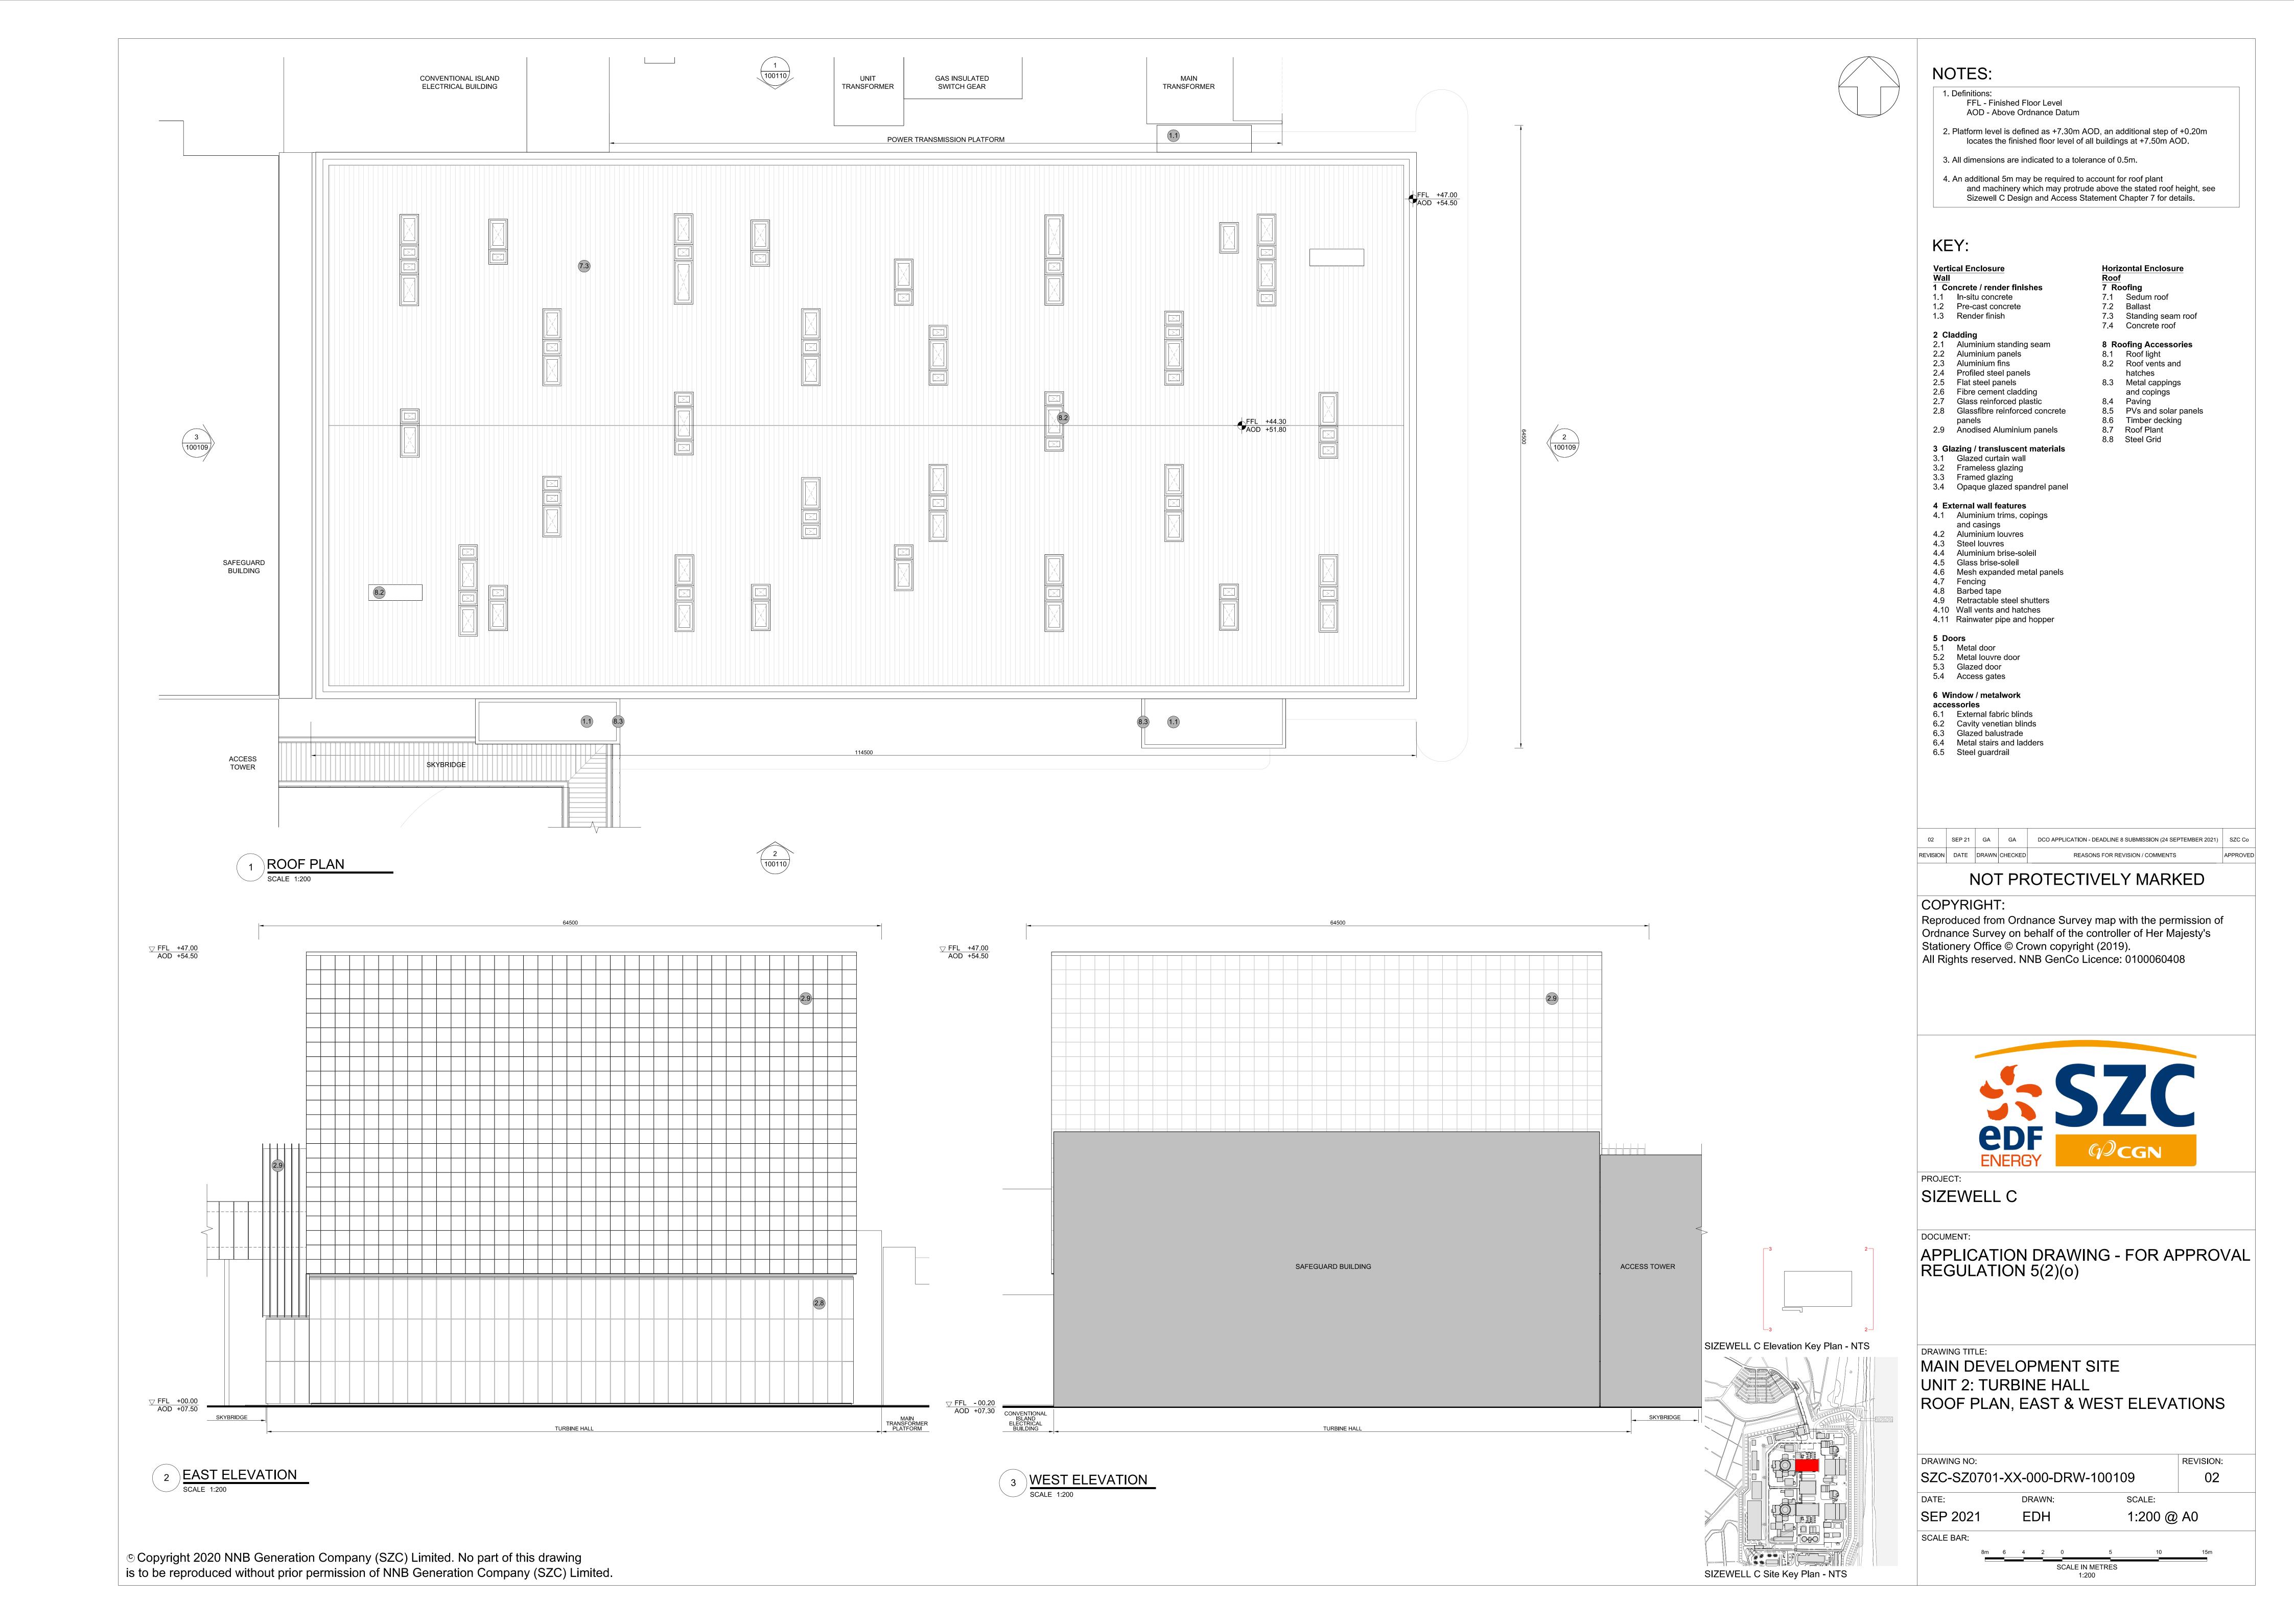

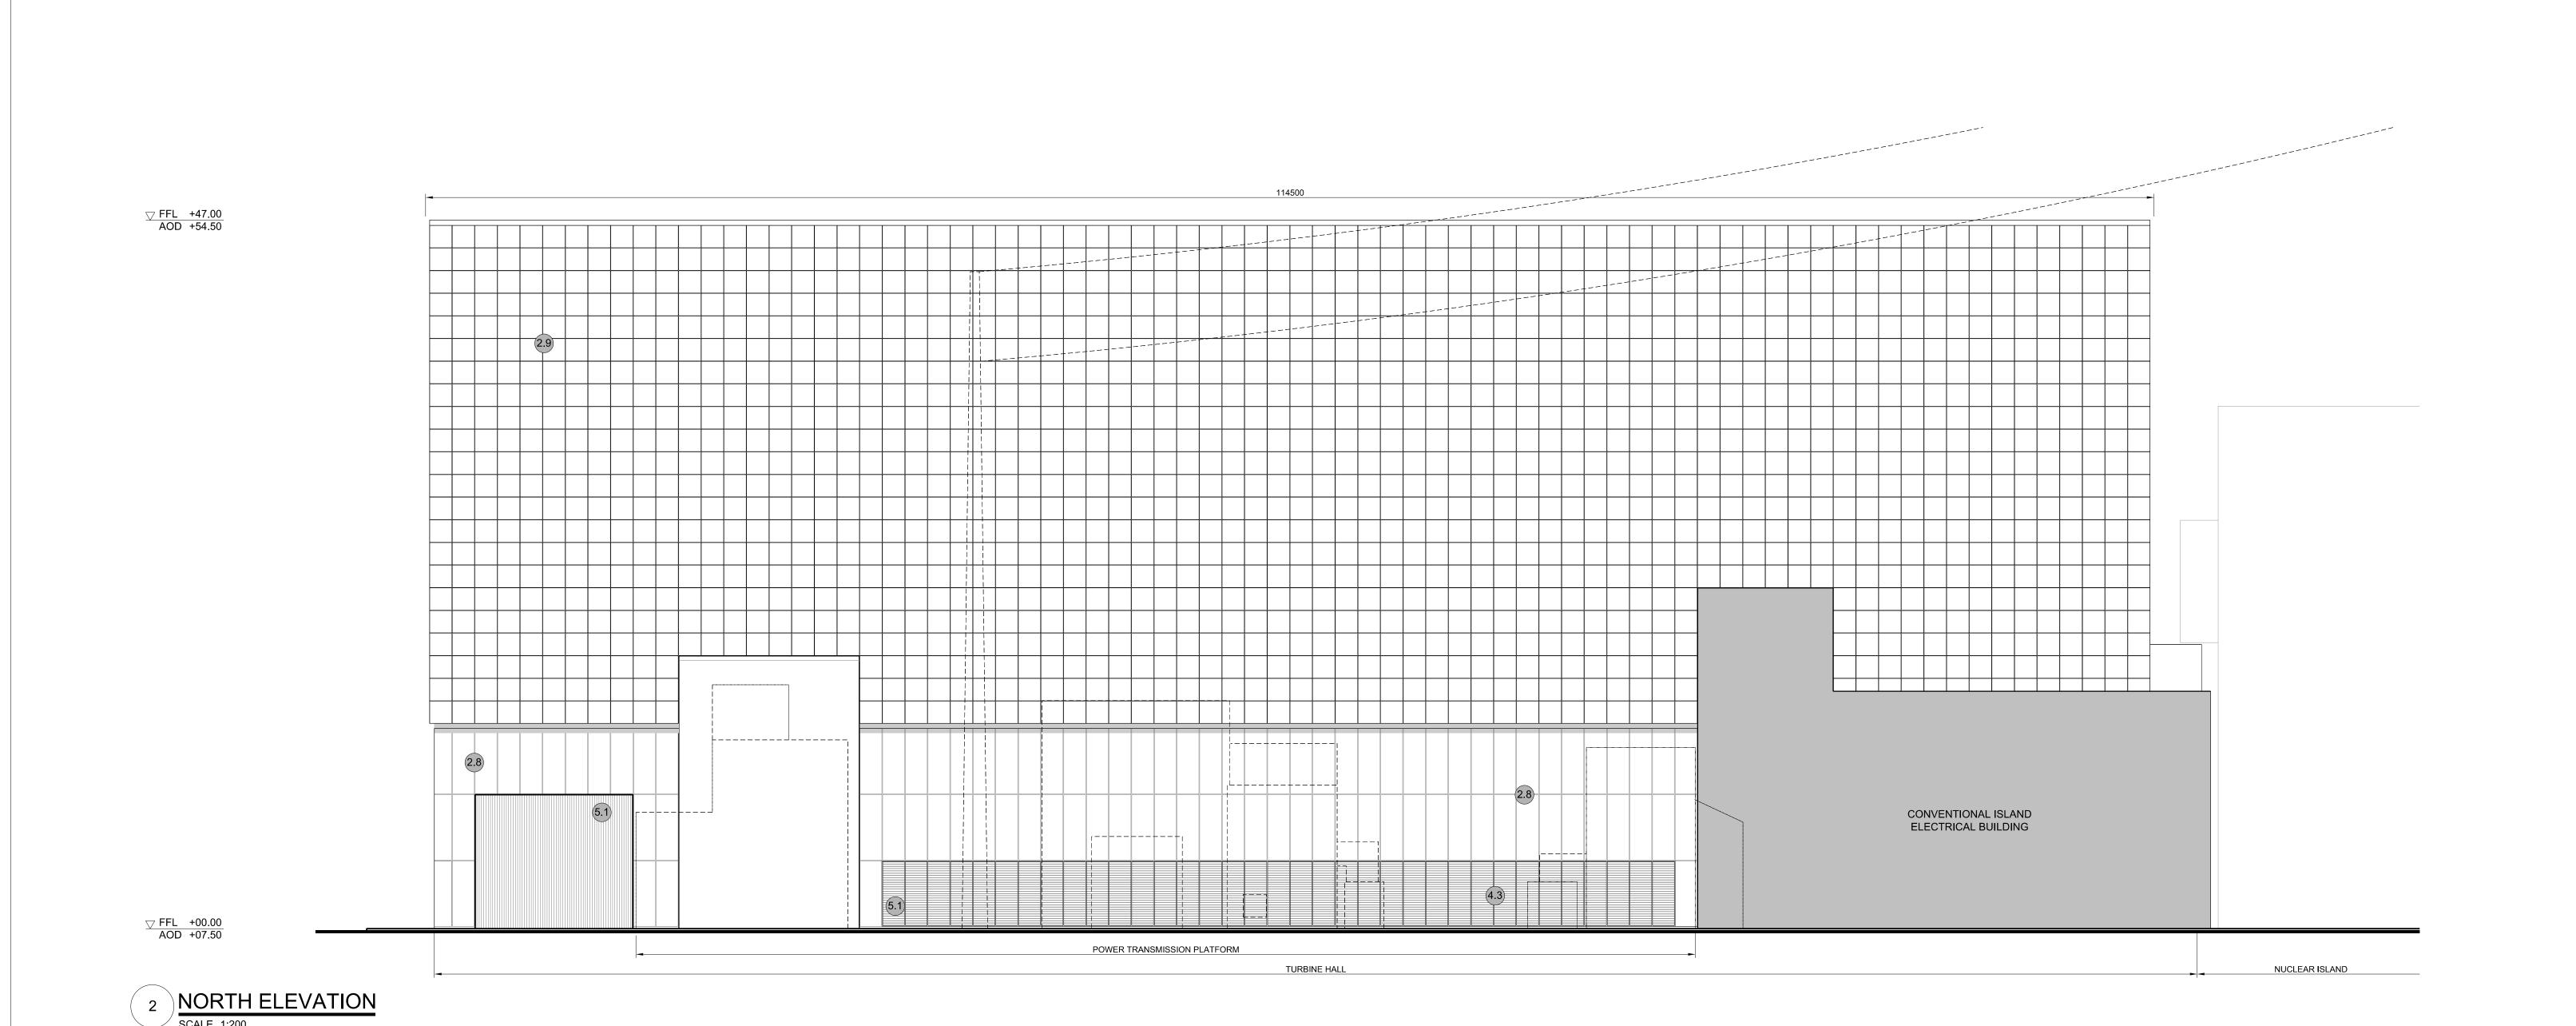

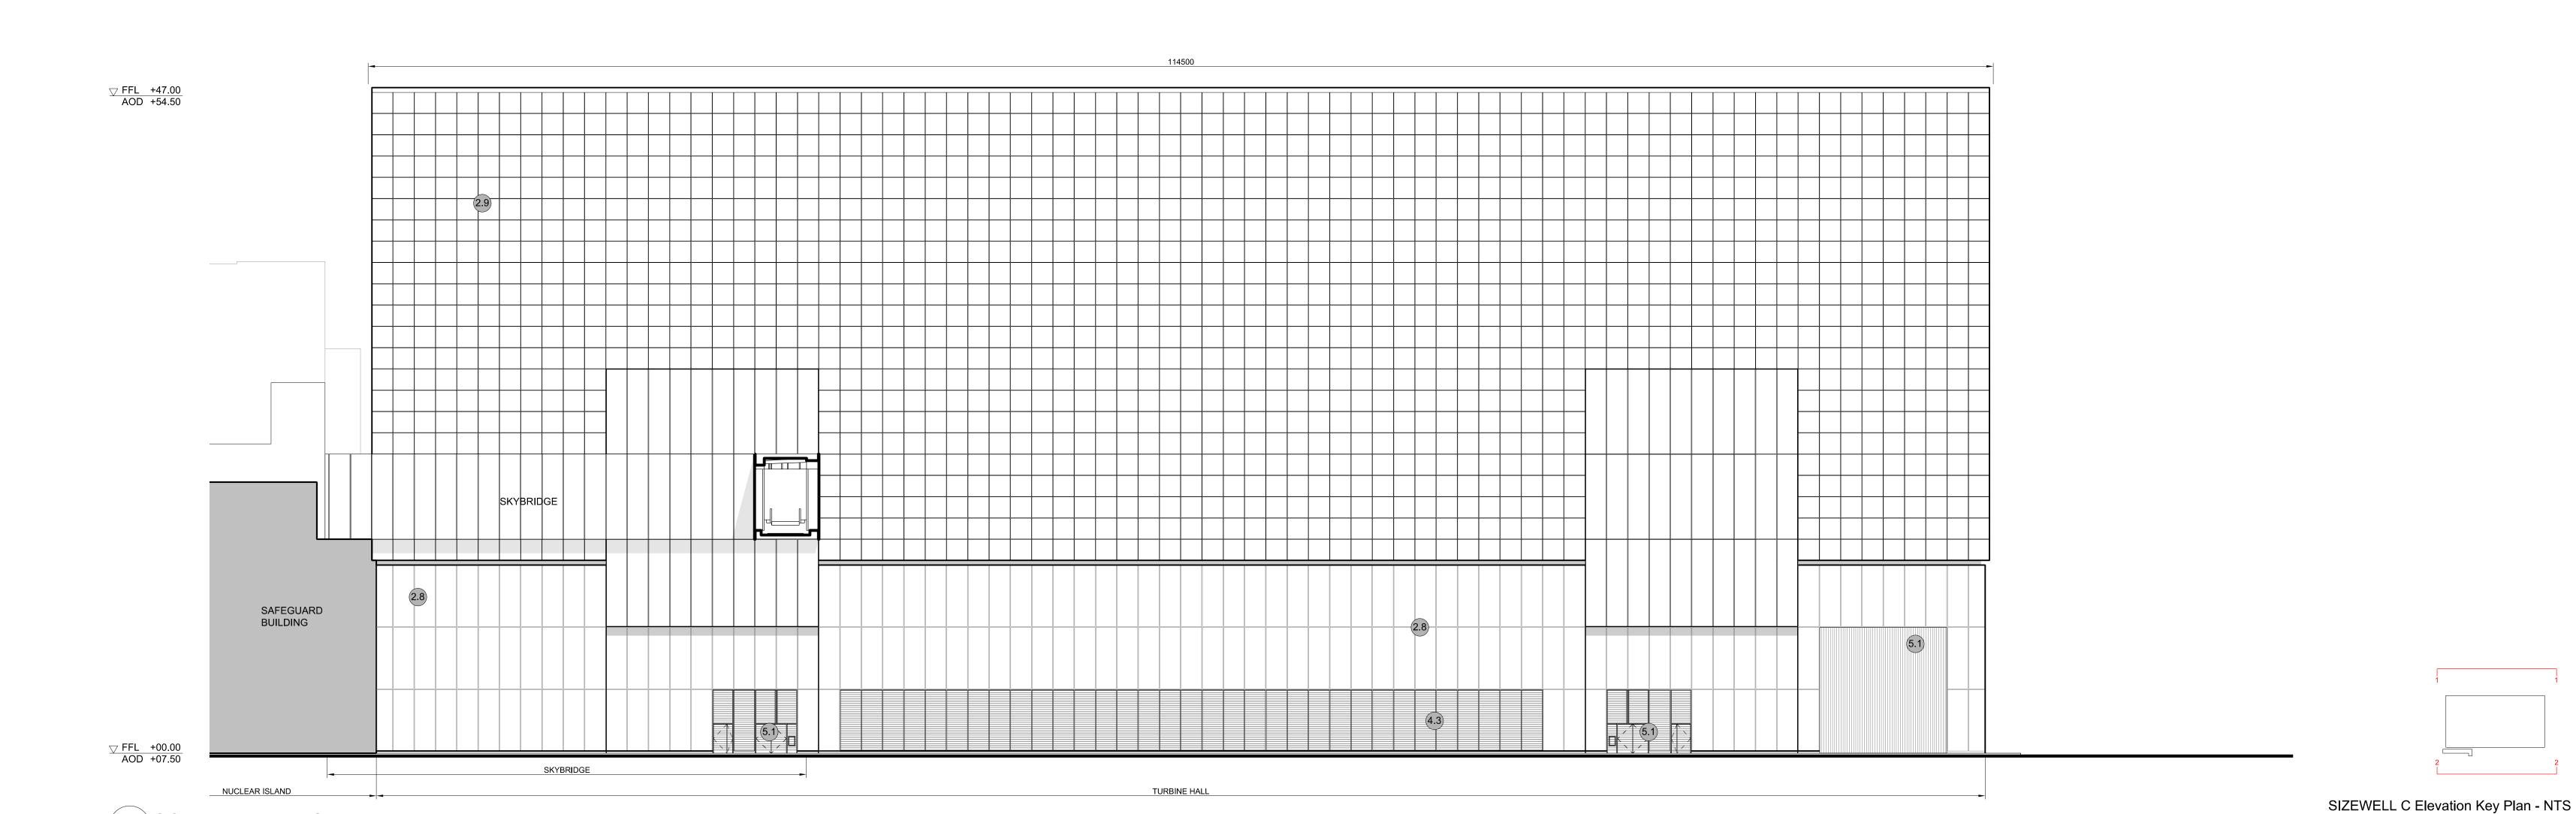

NOTES:

1. Definitions:

FFL - Finished Floor Level

AOD - Above Ordnance Datum

2. Platform level is defined as +7.30m AOD, an additional step of +0.20m locates the finished floor level of all buildings at +7.50m AOD.

3. All dimensions are indicated to a tolerance of 0.5m.

KEY:

Vertical Enclosure
Wall
1 Concrete / render finishes

1.1 In-situ concrete1.2 Pre-cast concrete1.3 Render finish

2 Cladding
2.1 Aluminium standing seam
2.2 Aluminium panels
2.3 Aluminium fins
2.4 Profiled steel panels
2.5 Flat steel panels

2.6 Fibre cement cladding
2.7 Glass reinforced plastic
2.8 Glassfibre reinforced concrete panels
2.9 Anodised Aluminium panels

3 Glazing / transluscent materials
3.1 Glazed curtain wall
3.2 Frameless glazing
3.3 Framed glazing

3.4 Opaque glazed spandrel panel4 External wall features4.1 Aluminium trims, copings

and casings
4.2 Aluminium louvres
4.3 Steel louvres
4.4 Aluminium brise-soleil
4.5 Glass brise-soleil

4.7 Fencing4.8 Barbed tape4.9 Retractable steel shutters4.10 Wall vents and hatches4.11 Rainwater pipe and hopper

4.6 Mesh expanded metal panels

5 Doors5.1 Metal door5.2 Metal louvre door5.3 Glazed door5.4 Access gates

accessories
6.1 External fabric blinds
6.2 Cavity venetian blinds
6.3 Glazed balustrade
6.4 Metal stairs and ladders
6.5 Steel guardrail

6 Window / metalwork

Horizontal Enclosure

Roof
7 Roofing
7.1 Sedum roof
7.2 Ballast
7.3 Standing seam roof

7.4 Concrete roof

8 Roofing Accessories
8.1 Roof light
8.2 Roof vents and hatches
8.3 Metal cappings and copings

8.4 Paving
8.5 PVs and solar panels
8.6 Timber decking
8.7 Roof Plant
8.8 Steel Grid

02 SEP 21 GA GA DCO APPLICATION - DEADLINE 8 SUBMISSION (24 SEPTEMBER 2021) SZC Co
REVISION DATE DRAWN CHECKED REASONS FOR REVISION / COMMENTS APPROVE

NOT PROTECTIVELY MARKED

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PROJECT: SIZEWELL C

DRAWING NO:

SIZEWELL C Site Key Plan - NTS

APPLICATION DRAWING - FOR APPROVAL REGULATION 5(2)(o)

DRAWING TITLE:
MAIN DEVELOPMENT SITE
UNIT 2: TURBINE HALL
NORTH & SOUTH ELEVATIONS

 SZC-SZ0701-XX-000-DRW-100110
 02

 DATE:
 DRAWN:
 SCALE:

 SEP 2021
 EDH
 1:200 @ A0


 SCALE BAR:

 SCALE IN METRES

REVISION:

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SOUTH ELEVATION
SCALE 1:200



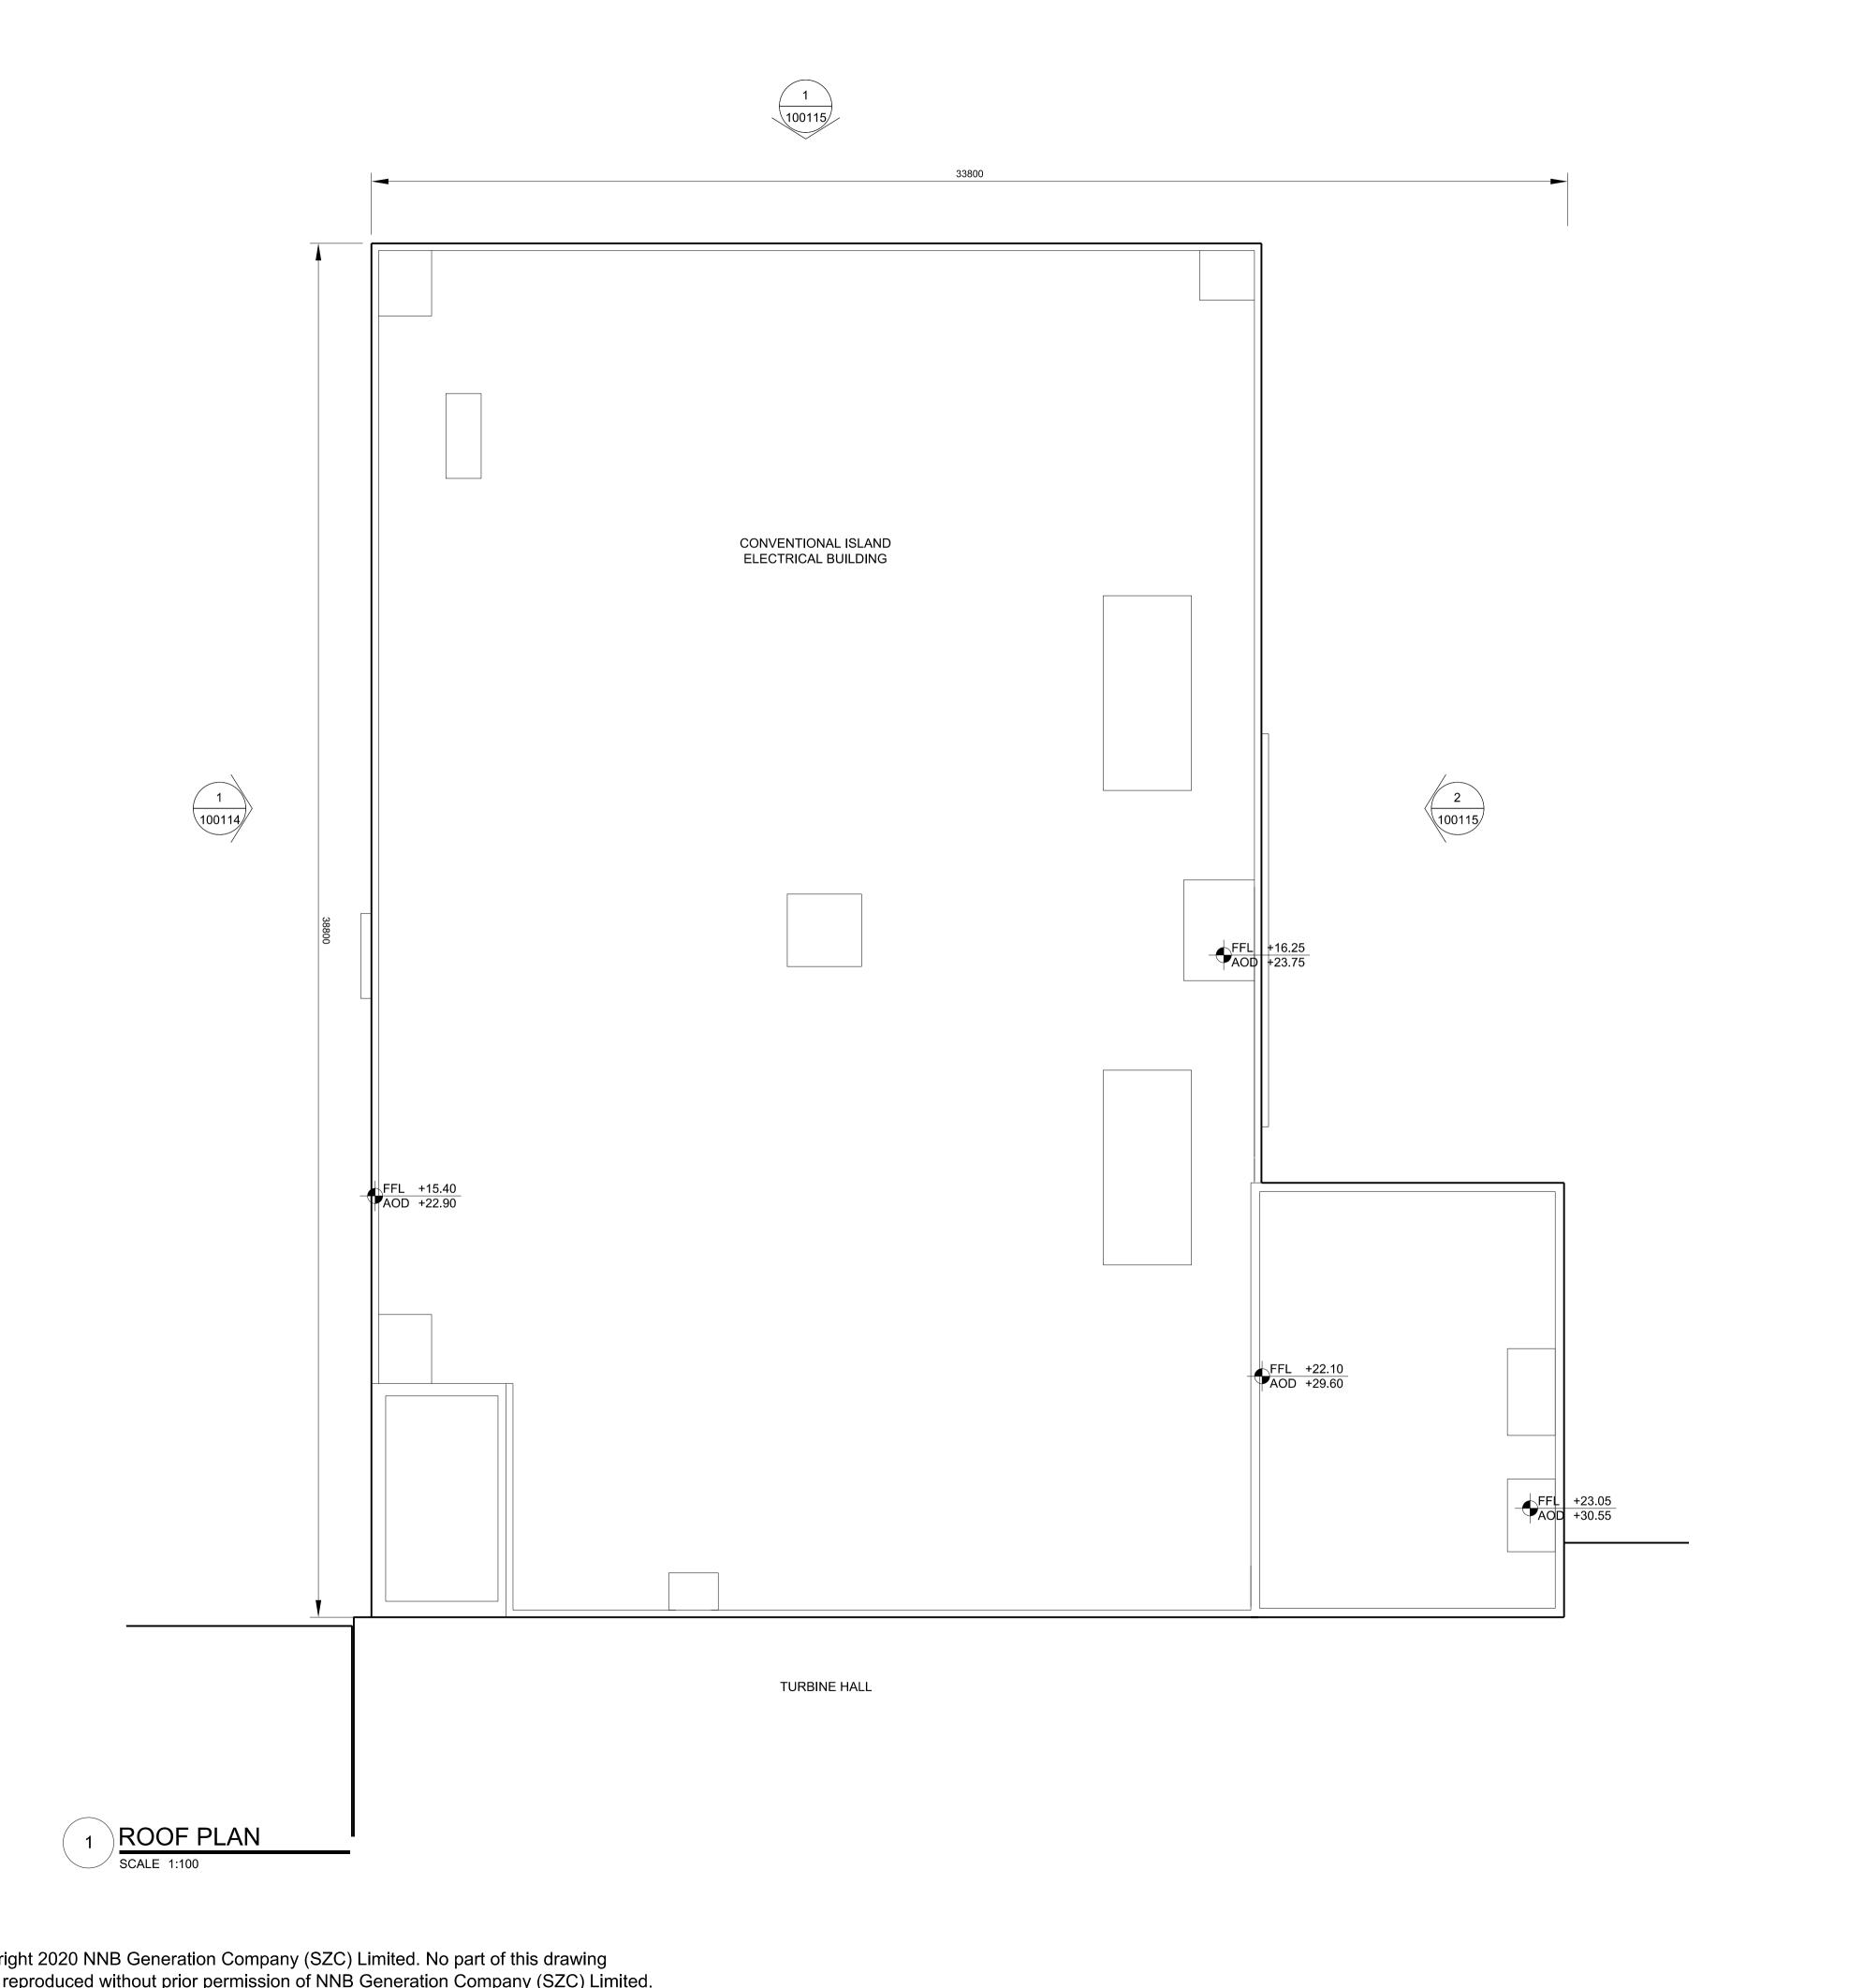

1. Definitions: FFL - Finished Floor Level AOD - Above Ordnance Datum

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3. All dimensions are indicated to a tolerance of 0.5m.

4. An additional 5m may be required to account for roof plant and machinery which may protrude above stated roof height, see Sizewell C Design and Access Statement for details.

5 Doors

5.1 Metal door

5.3 Glazed door 5.4 Access gates

accessories

5.2 Metal louvre door

6.1 External fabric blinds 6.2 Cavity venetian blinds

6.3 Glazed balustrade

6.4 Metal stairs and

ladders

6.5 Steel guardrail

Horizontal Enclosure

7.3 Standing seam roof

8 Roofing Accessories

and copings

8.5 PVs and solar panels

8.6 Timber decking

8.2 Roof vents and

hatches 8.3 Metal cappings

8.4 Paving

8.7 Roof Plant

8.8 Steel Grid

7.1 Sedum roof

7.4 Concrete roof

7 Roofing

7.2 Ballast

Vertical Enclosure

1 Concrete / render finishes 1.1 In-situ concrete

1.2 Pre-cast concrete 1.3 Render finish

2 Cladding

2.1 Aluminium standing seam 6 Window / metalwork 2.2 Aluminium panels

2.3 Aluminium fins 2.4 Profiled steel panels

2.5 Flat steel panels 2.6 Fibre cement cladding 2.7 Glass reinforced plastic 2.8 Glassfibre reinforced

concrete panels 2.9 Anodised Aluminium panels

3 Glazing / transluscent materials

3.1 Glazed curtain wall 3.2 Frameless glazing

panel

3.3 Framed glazing 3.4 Opaque glazed spandrel

4 External wall features 4.1 Aluminium trims, copings 8.1 Roof light

and casings 4.2 Aluminium louvres

4.3 Steel louvres 4.4 Aluminium brise-soleil

4.5 Glass brise-soleil 4.6 Mesh expanded metal panels

4.7 Fencing 4.8 Barbed tape 4.9 Retractable steel shutters

4.10 Wall vents and hatches 4.11 Rainwater pipe and hopper

DCO APPLICATION - DEADLINE 8 SUBMISSION 02 | SEP 21 | GA | GA | (24 SEPTEMBER 2021) REVISION DATE DRAWN CHECKED REASONS FOR REVISION / COMMENTS

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SIZEWELL C

APPLICATION DRAWING - FOR APPROVAL REGULATION 5(2)(o)

DRAWING TITLE:

DRAWING NO:


MAIN DEVELOPMENT SITE UNIT 2: CONVENTIONAL ISLAND ELECTRICAL BUILDING ROOF PLAN

| SZC-SZ0701-XX-000-DRW-100113 | | | | | | | 02 |
|------------------------------|---|----|--------|---------|--------|--------|----|
| DATE: | | DR | DRAWN: | | SCALE: | SCALE: | |
| SEP 2021 EDH | | | | 1:100 @ | A1 | | |
| SCALE BAR: 5m 4 | 3 | 2 | 1 | 0 | 2 | 4 | 6m |
| SCALE IN METRES 1:100 | | | | | | | |

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KEY: Vertical Enclosure

1 Concrete / render finishes 1.1 In-situ concrete 1.2 Pre-cast concrete

1.3 Render finish

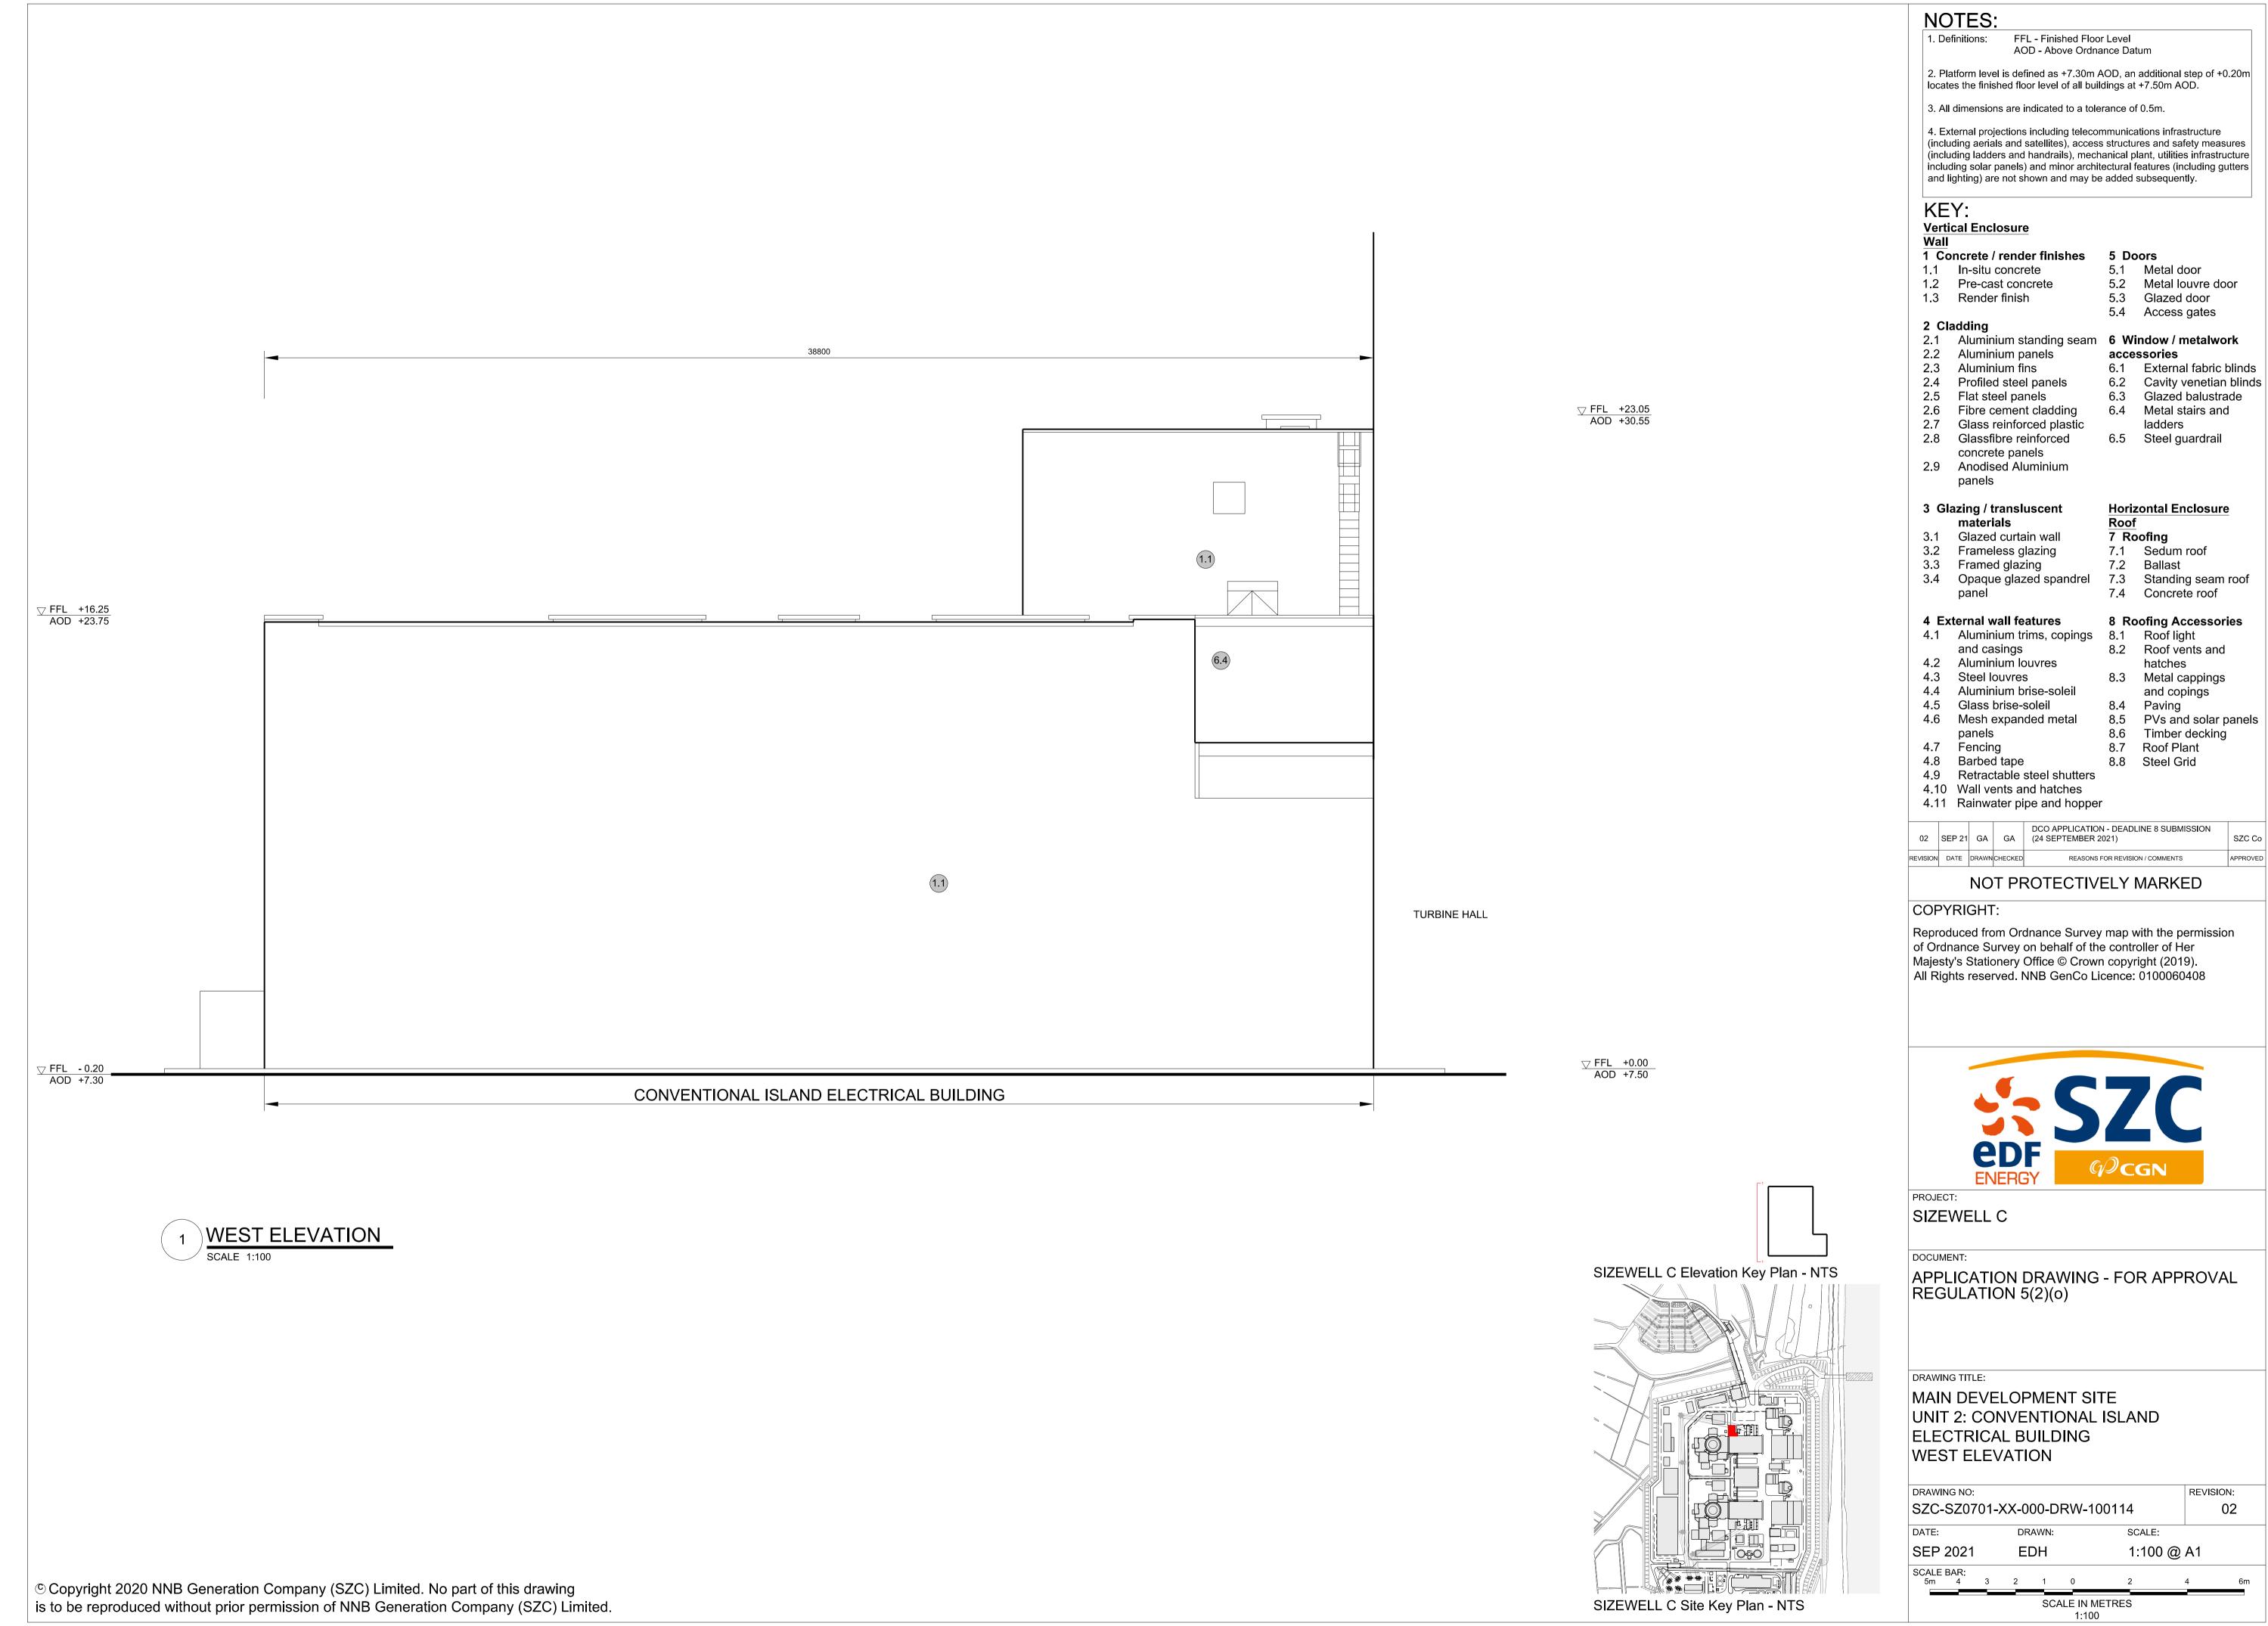5.2 Metal louvre door 5.3 Glazed door 5.4 Access gates

accessories

6.1 External fabric blinds 6.2 Cavity venetian blinds

6.3 Glazed balustrade

6.4 Metal stairs and

Horizontal Enclosure

7.3 Standing seam roof

8 Roofing Accessories

and copings

8.5 PVs and solar panels

8.6 Timber decking

8.2 Roof vents and

hatches 8.3 Metal cappings

8.4 Paving

8.7 Roof Plant

8.8 Steel Grid

7.1 Sedum roof

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7.2 Ballast

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2 Cladding

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2.7 Glass reinforced plastic ladders 2.8 Glassfibre reinforced 6.5 Steel guardrail concrete panels 2.9 Anodised Aluminium

3 Glazing / transluscent

materials

panels

3.1 Glazed curtain wall 3.2 Frameless glazing 3.3 Framed glazing 3.4 Opaque glazed spandrel

7.4 Concrete roof 4 External wall features

4.1 Aluminium trims, copings 8.1 Roof light and casings 4.2 Aluminium louvres

4.3 Steel louvres 4.4 Aluminium brise-soleil 4.5 Glass brise-soleil 4.6 Mesh expanded metal

panels 4.7 Fencing 4.8 Barbed tape

4.9 Retractable steel shutters 4.10 Wall vents and hatches 4.11 Rainwater pipe and hopper

DCO APPLICATION - DEADLINE 8 SUBMISSION 02 | SEP 21 | GA | GA | (24 SEPTEMBER 2021) REASONS FOR REVISION / COMMENTS REVISION DATE DRAWN CHECKED

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SIZEWELL C

APPLICATION DRAWING - FOR APPROVAL REGULATION 5(2)(o)

MAIN DEVELOPMENT SITE

DRAWING NO:

UNIT 2: GAS INSULATED SWITCH GEAR BUILDING / MAIN TRANSFORMER PLATFORM / UNIT TRANSFORMER / AUXILIARY TRANSFORMER PLATFORM ROOF PLAN

| SZC-SZ0701 | 02 | | | | | | |
|--------------------------|--------|---------|------------|--|--|--|--|
| DATE: | DRAWN: | SCALE: | | | | | |
| SEP 2021 | EDH | 1:200 @ | 1:200 @ A1 | | | | |
| SCALE BAR: 8m 6 4 | 2 0 | 5 10 | 15m | | | | |
| SCALE IN METRES 1:200 | | | | | | | |



